
PROPOSED "CONVENIENCE STORE & GAS STATION" LOCATED AT 1001 W VILLA MARIA RD, BRYAN, TX 77801

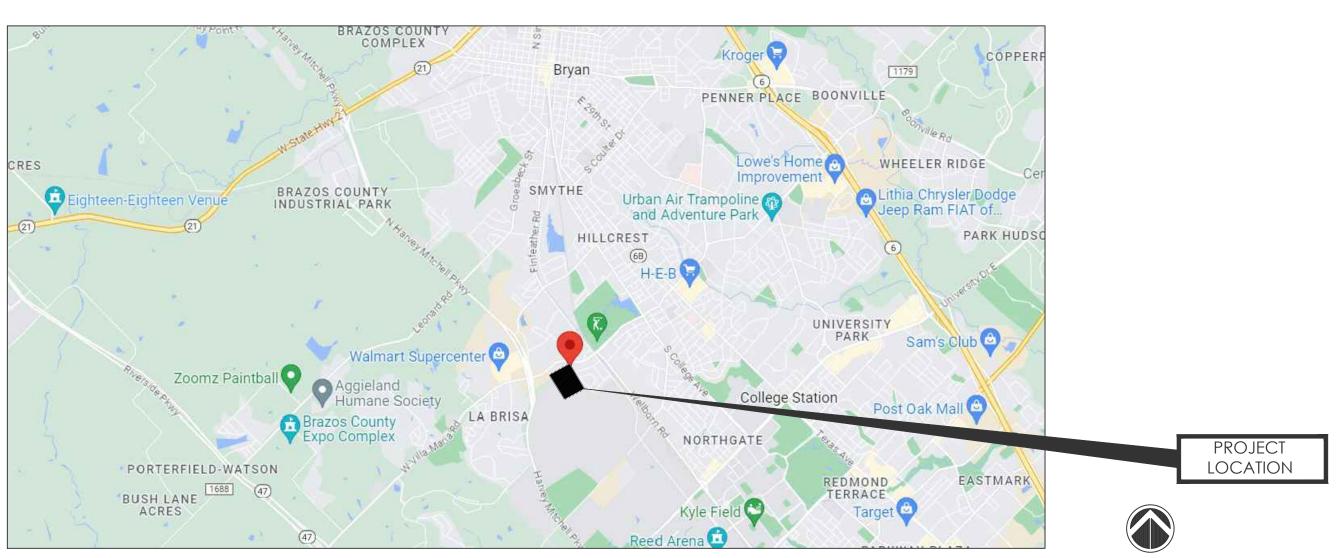

WE ARE NOT RESPONSIBLE FOR THE F.I.R.M.'S ACCURACY.

MAKMO DESIGN - DESIGN WITH A DIFFERENT APPROACH —

PROJECT DESCRIPTION

PROJECT NAME : PROPOSED C-STORE & GAS STATION

LOCATION : 1001 W VILLA MARIA RD, BRYAN, TX 77801

PROJECT DESCRIPTION : A GROUND UP CONSTRUCTION OF A ONE STORY

C-STORE BUILDINGS 7,136 SQ.FT

SHEET INDEX

<u>CIVIL</u>


C-0.0	COVER SHEET
C-0.1	TOPOGRAPHIC SURVEY
C-1.0	SITE PLAN
C-2.0	GRADING PLAN
C-2.1	DRAINAGE PLAN
C-2.2	DRAINAGE CALCULATIONS
C-2.3	SITE SECTION


EROSION AND SEDIMENT CONTROL PLAN UTILITY PLAN

PAVING PLAN SITE DETAILS C-6.0 CONSTRUCTION DETAILS-1 CONSTRUCTION DETAILS-2 SWPPP DETAILS LANDSCAPE PLAN

ISSUE FOR: FOR INTER REVIEW ONLY PERMITS SET CONSTRUCTION SET

REVISIONS: NO. DATE DESCRIPTION

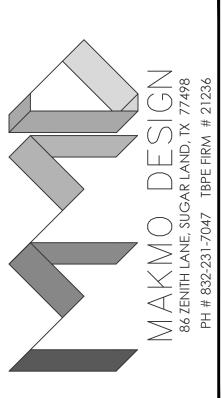

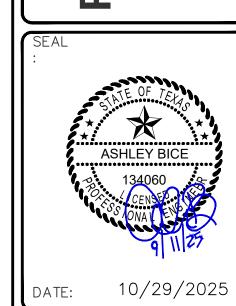



PROJECT NUMBER	23-000
SCALE	N/A
DRAWN BY	R::R
CHECKED BY	A.Z
SHEET TITLE :	
	SCALE DRAWN BY CHECKED BY

COVER SHEET

DRAWING NUMBER:

C-0.0

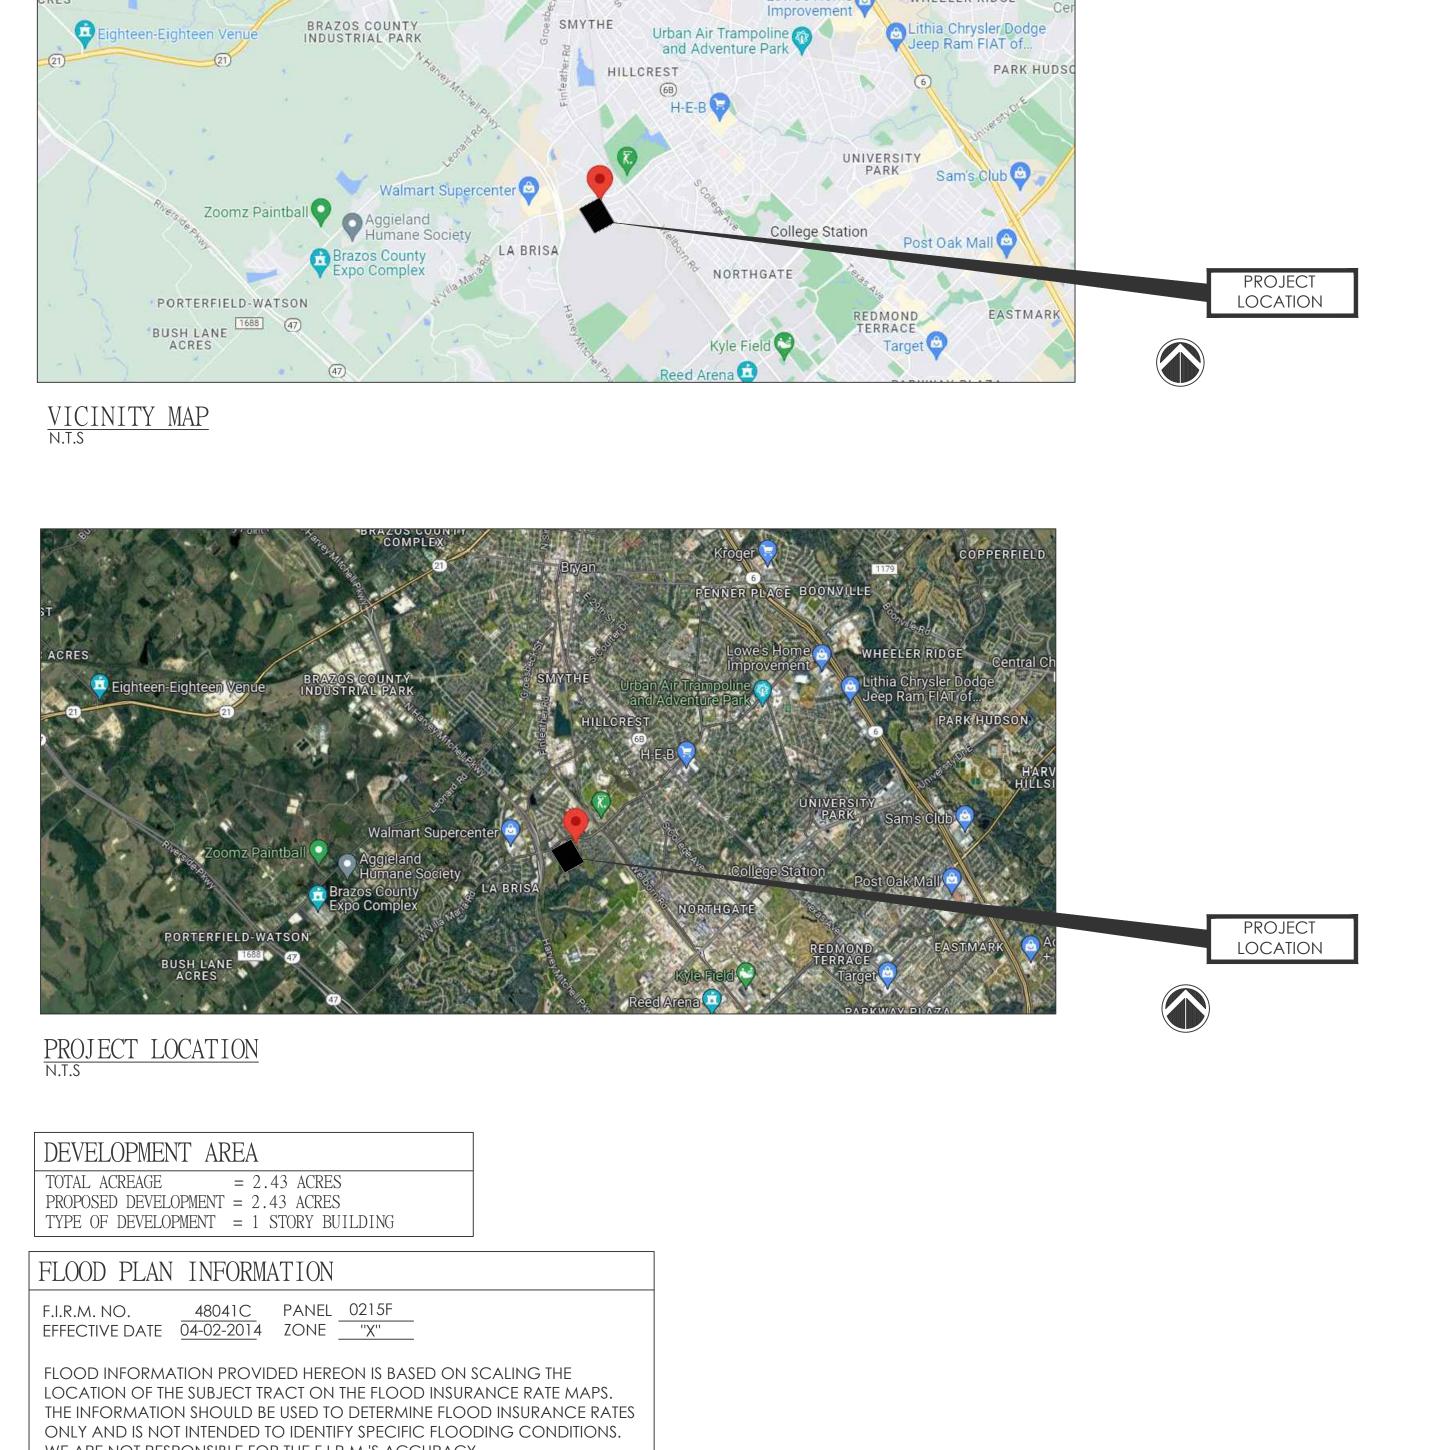

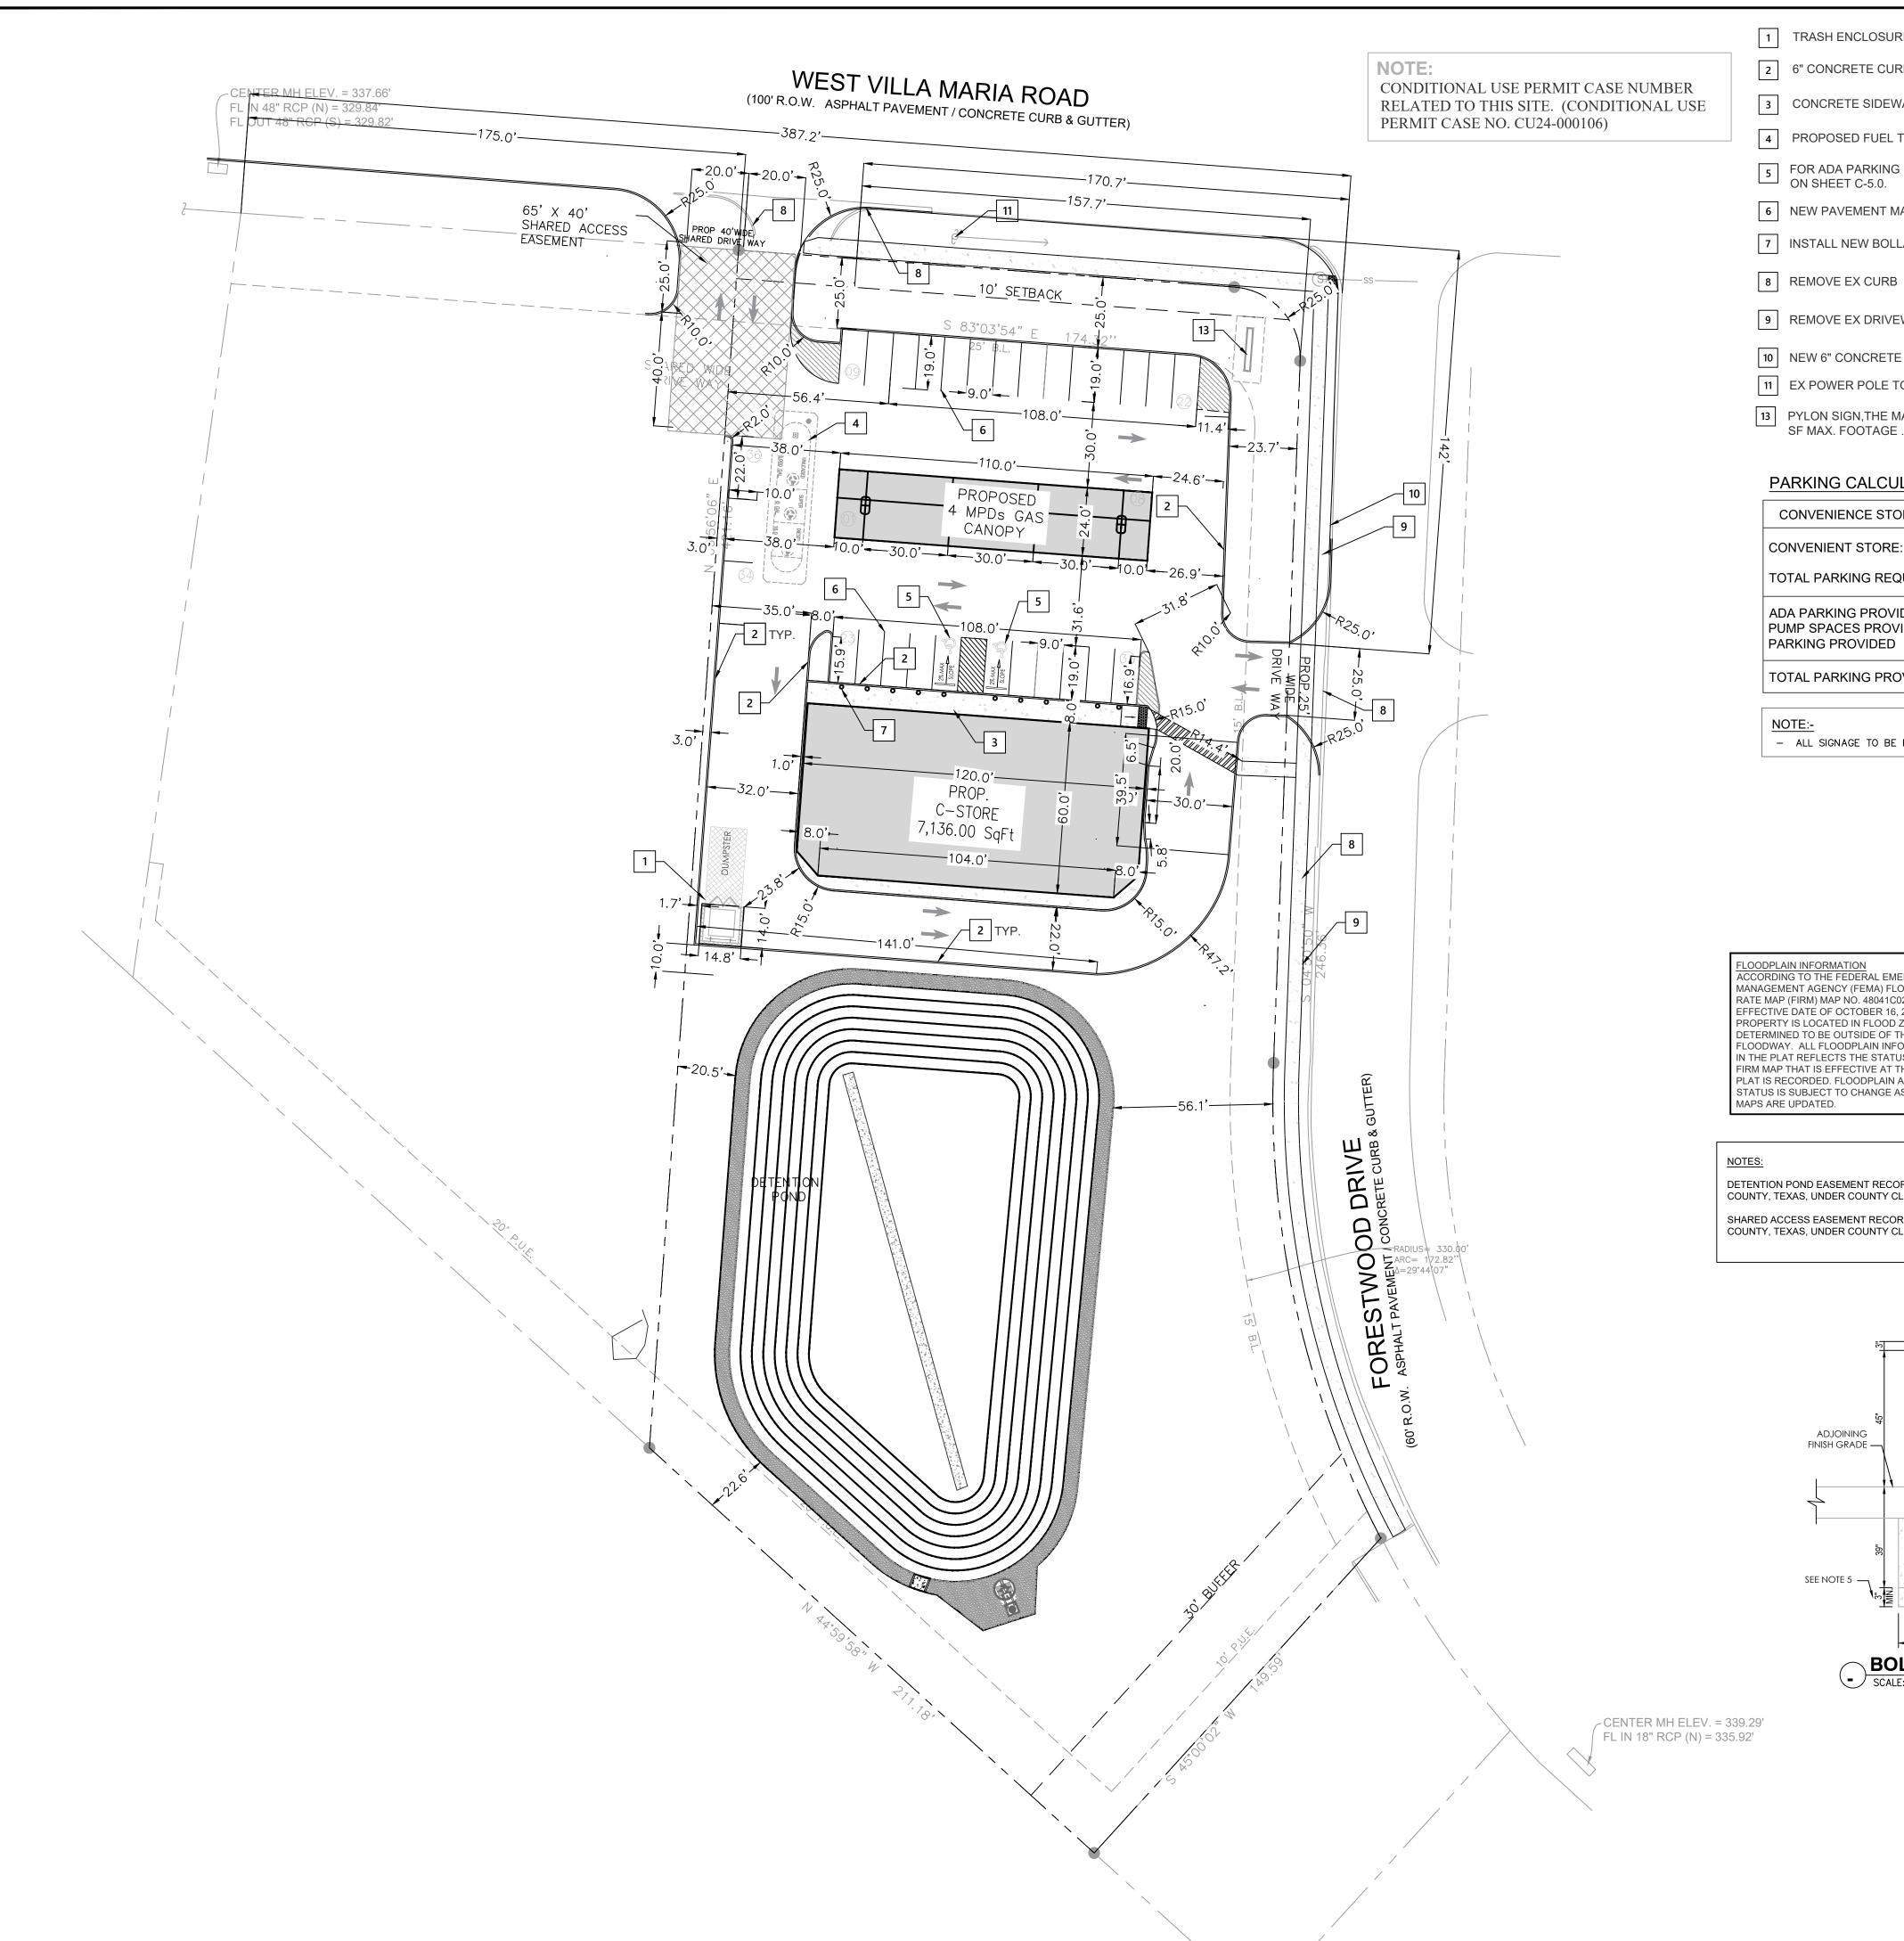

MAKMO DESIGN - DESIGN WITH A DIFFERENT APPROACH

1 TRASH ENCLOSURE SEE DETAIL ON SHEET C-6.0.

2 6" CONCRETE CURB SEE DETAIL ON SHEET C-6.0.

3 CONCRETE SIDEWALK SEE DETAIL ON SHEET C-6.0.

4 PROPOSED FUEL TANK BY OTHERS.

FOR ADA PARKING DETAIL AND SIGN REFER DETAIL ON SHEET C-5.0.

6 NEW PAVEMENT MARKING FOR PARKING SPACES

7 INSTALL NEW BOLLARDS. SEE DETAIL ON THIS SHEET.

9 REMOVE EX DRIVEWAY.

10 NEW 6" CONCRETE CURB PER CITY OF BRYAN.

11 EX POWER POLE TO REMAIN. PROTECT IN PLACE.

13 PYLON SIGN,THE MAXIMUM SIGN HEIGHT 8' WITH 150 SF MAX. FOOTAGE . TO BE APPROVED BY OWNER

PARKING CALCULATION:-

CONVENIENCE STORE (TYPE M)		
CONVENIENT STORE: 7136.00 Sqft /250	= 29	
TOTAL PARKING REQUIRED	= 29	
ADA PARKING PROVIDED PUMP SPACES PROVIDED PARKING PROVIDED	= 2 = 8 = 25	
TOTAL PARKING PROVIDED	= 35	

- ALL SIGNAGE TO BE PERMITTED SEPARATLY

CCORDING TO THE FEDERAL EMERGENCY MANAGEMENT AGENCY (FEMA) FLOOD INSURANCE RATE MAP (FIRM) MAP NO. 48041C0215F, WITH THE EFFECTIVE DATE OF OCTOBER 16, 2014, THE ROPERTY IS LOCATED IN FLOOD ZONE " X " AREAS DETERMINED TO BE OUTSIDE OF THE REGULATED FLOODWAY. ALL FLOODPLAIN INFORMATION NOTED IN THE PLAT REFLECTS THE STATUS PER THE FEMA FIRM MAP THAT IS EFFECTIVE AT THE TIME THAT THE PLAT IS RECORDED. FLOODPLAIN AND FLOODWAY STATUS IS SUBJECT TO CHANGE AS FEMA FIRM

DIMENSION LAYOUT NOTES:

- THE CONTRACTOR SHALL LAYOUT AND VERIFY ALL DIMENSIONS PRIOR TO CONSTRUCTION. ANY DISCREPANCIES SHALL BE BROUGHT TO THE ATTENTION OF THE ENGINEER FOR DIRECTION AND RESOLUTION OF
- DISCREPANCIES PRIOR TO PROCEEDING. VERIFY LOCATIONS OF ALL SITE IMPROVEMENTS INSTALLED UNDER OTHER SECTIONS. IF ANY PART OF THIS PLAN CANNOT BE FOLLOWED DUE TO SITE CONDITIONS, CONTACT THE ENGINEER FOR INSTRUCTION PRIOR TO COMMENCING WORK.
 - WRITTEN DIMENSIONS TAKE PRECEDENCE OVER SCALE.
- WHERE DIMENSIONS ARE CALLED AS "EQUAL", ALL REFERENCED ITEMS SHALL BE SPACED EQUALLY, MEASURED TO THEIR CENTER LINES. ALL DIMENSIONS ARE PERPENDICULAR TO FACE OF BUILDING, WALL OR OTHER FIXED SITE IMPROVEMENT AND DIMENSIONS AT CURB ARE FROM
- BACK OF CURB UNLESS OTHERWISE NOTED. INSTALL ALL INTERSECTING ELEMENTS AT 90 DEGREES TO EACH OTHER UNLESS OTHERWISE NOTED.

EXPANSION JOINTS:

PROVIDE EXPANSION JOINTS IN ALL CASES WHERE CONCRETE FLATWORK MEETS OTHER STRUCTURES SUCH AS WALLS, CURBS, STEPS & BUILDINGS OR WHERE CONCRETE ABUTS EXISTING CONCRETE PAVING, UTILITY VAULTS, JUNCTION BOXES, ETC. EXPANSION JOINTS REQUIRED AT THESE STRUCTURES MAY NOT BE SHOWN ON THESE DRAWINGS BUT ARE A CONSTRUCTION REQUIREMENT. SEE DETAILS FOR LOCATIONS THAT REQUIRE INSTALLATION OF DOWELS.


GENERAL NOTES

- LOCATIONS OF THE EXISTING UTILITIES ARE BASED ON RECORDS FROM SAID UTILITY COMPANIES AND ARE HORIZONTALLY FIELD LOCATED ONLY. THE CONTRACTORS SHALL BE RESPONSIBLE FOR DETERMINING ACTUAL
- LOCATION. CONTRACTOR TO UNCOVER AND MARK UTILITY LINES BEFORE
- CONSTRUCTION.
- CONTRACTOR SHALL BEAR ALL RESPONSIBILITY AND COST OF REPAIR OR REPLACEMENT OF EXISTING UTILITIES, DAMAGED OR INTERRUPTED AS A RESULT OF THIS CONSTRUCTION PROJECT CONTRACTOR SHALL NOTIFY THE PROJECT ENGINEER AND THE OWNER OF
- ANY DAMAGED OR INTERRUPTED UTILITIES IMMEDIATELY. ALL WATER LINES AND APPURTENANCES SHALL BE INSTALLED IN ACCORDANCE WITH LOCAL WATER STANDARD PIPELINE MATERIALS AND CONSTRUCTION SPECIFICATIONS, LATEST EDITION.
- EXISTING UTILITIES TO REMAIN ARE TO BE ADJUSTED TO MATCH PROPOSED GRADE.
- CONTRACTOR SHALL NOTIFY PROJECT ENGINEER PRIOR TO BEGINNING ALL AREAS WITHIN THE PAVED AREAS ARE TO RECEIVE A GRAVEL BASE TO
- PROVIDE EROSION CONTROL IF WORK IS NOT PROGRESSING IN AN ORDERLY MANNER. A RATE OF 135 TONS/ACRE IS TO BE APPLIED WITHIN
- TWO WEEKS OF FINAL GRADING. ALL AREAS NOT WITHIN THE PAVED AREA ARE TO RECEIVE LOOSE STRAW TO PROVIDE EROSION CONTROL IF WORK IS NOT PROGRESSING IN AN ORDERLY MANNER. A RATE OF 1.5 TONS/ACRE IS TO BE APPLIED WITHIN TWO WEEKS OF FINAL GRADING.
- . AFTER NEW INLETS ARE CONSTRUCTED, INSTALL INLET PROTECTION PER . CONTRACTOR WILL CONTROL AND PREVENT OFF-SITE TRACKING OF
- CONSTRUCTION RUNOFF AND SEDIMENT TO ADJACENT PROPERTY AND PUBLIC ROADS.
- . CONTRACTOR IS TO PROTECT EXISTING STORM DRAINAGE SYSTEM CONTRACTOR TO CONFORM TO ALL CONSTRUCTION STORM WATER AND EROSION CONTROL PERMITTING REQUIREMENTS BY "EPA PHASE II STORM WATER REGULATIONS" AS ADMINISTERED BY THE TEXAS COMMISSION OF ENVIRONMENTAL QUALITY. WHERE PERMITTING IS REQUIRED, A COPY OF THE NOTICE OF INTENT SHALL BE PROVIDED TO THE LOCAL MUNICIPAL AUTHORITY
- 4. CONTRACTOR SHALL LOCATE ALL EXISTING UTILITIES IN ACCORDANCE WITH THE TEXAS UNDERGROUND FACILITIES DAMAGE PREVENTION ACT. THIS LAW REQUIRES THAT THE CONTRACTOR MAKE A TELEPHONE CALL TO THE CITY OF BRYAN PUBLIC WORKS (979-209-5900) AT LEAST TWO WORKING DAYS PRIOR TO EXCAVATION TO ENSURE THAT ANY EXISTING UTILITIES CAN BE LOCATED. 5. CONTRACTOR TO CONSTRUCT ALL ACCESS RAMPS AND PAVING TO ADA
- STANDARDS, VERIFY. 16. TREES TO REMAIN ARE TO BE PROTECTED FROM DAMAGE DURING
- CONSTRUCTION.
- . EXCESS EXPORTS SHALL BE STOCKPILED AT LOCATION APPROVED BY OWNER AND CONFIRMED BY ENGINEER OF RECORD.

SEE ARCHITECTURAL PLANS FOR BUILDING DIMENSIONS ALL DIMENSIONS ARE TO BACK OF CURB UNLESS NOTED OTHERWISE

DETENTION POND EASEMENT RECORDED AND FILED IN THE OFFICIAL PUBLIC RECORDS OF BRAZOS COUNTY, TEXAS, UNDER COUNTY CLERK'S FILE NO. <u>1563509</u>, VOL. <u>20010</u>, PG. <u>3</u>.

SHARED ACCESS EASEMENT RECORDED AND FILED IN THE OFFICIAL PUBLIC RECORDS OF BRAZOS COUNTY, TEXAS, UNDER COUNTY CLERK'S FILE NO. <u>1563508</u>, VOL. <u>20010</u>, PG. <u>3</u>.

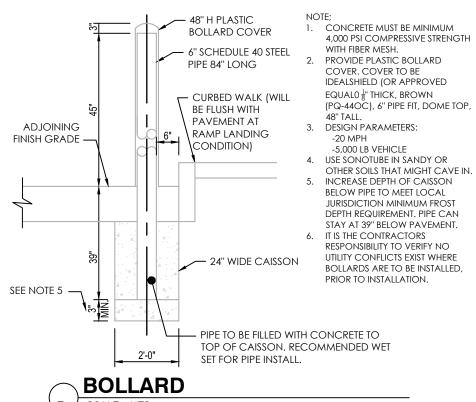





SSUE FOR:

BID ONLY

PERMITS SET

REVISIONS:

FOR INTER REVIEW ONLY

NO. DATE DESCRIPTION

CONSTRUCTION SET

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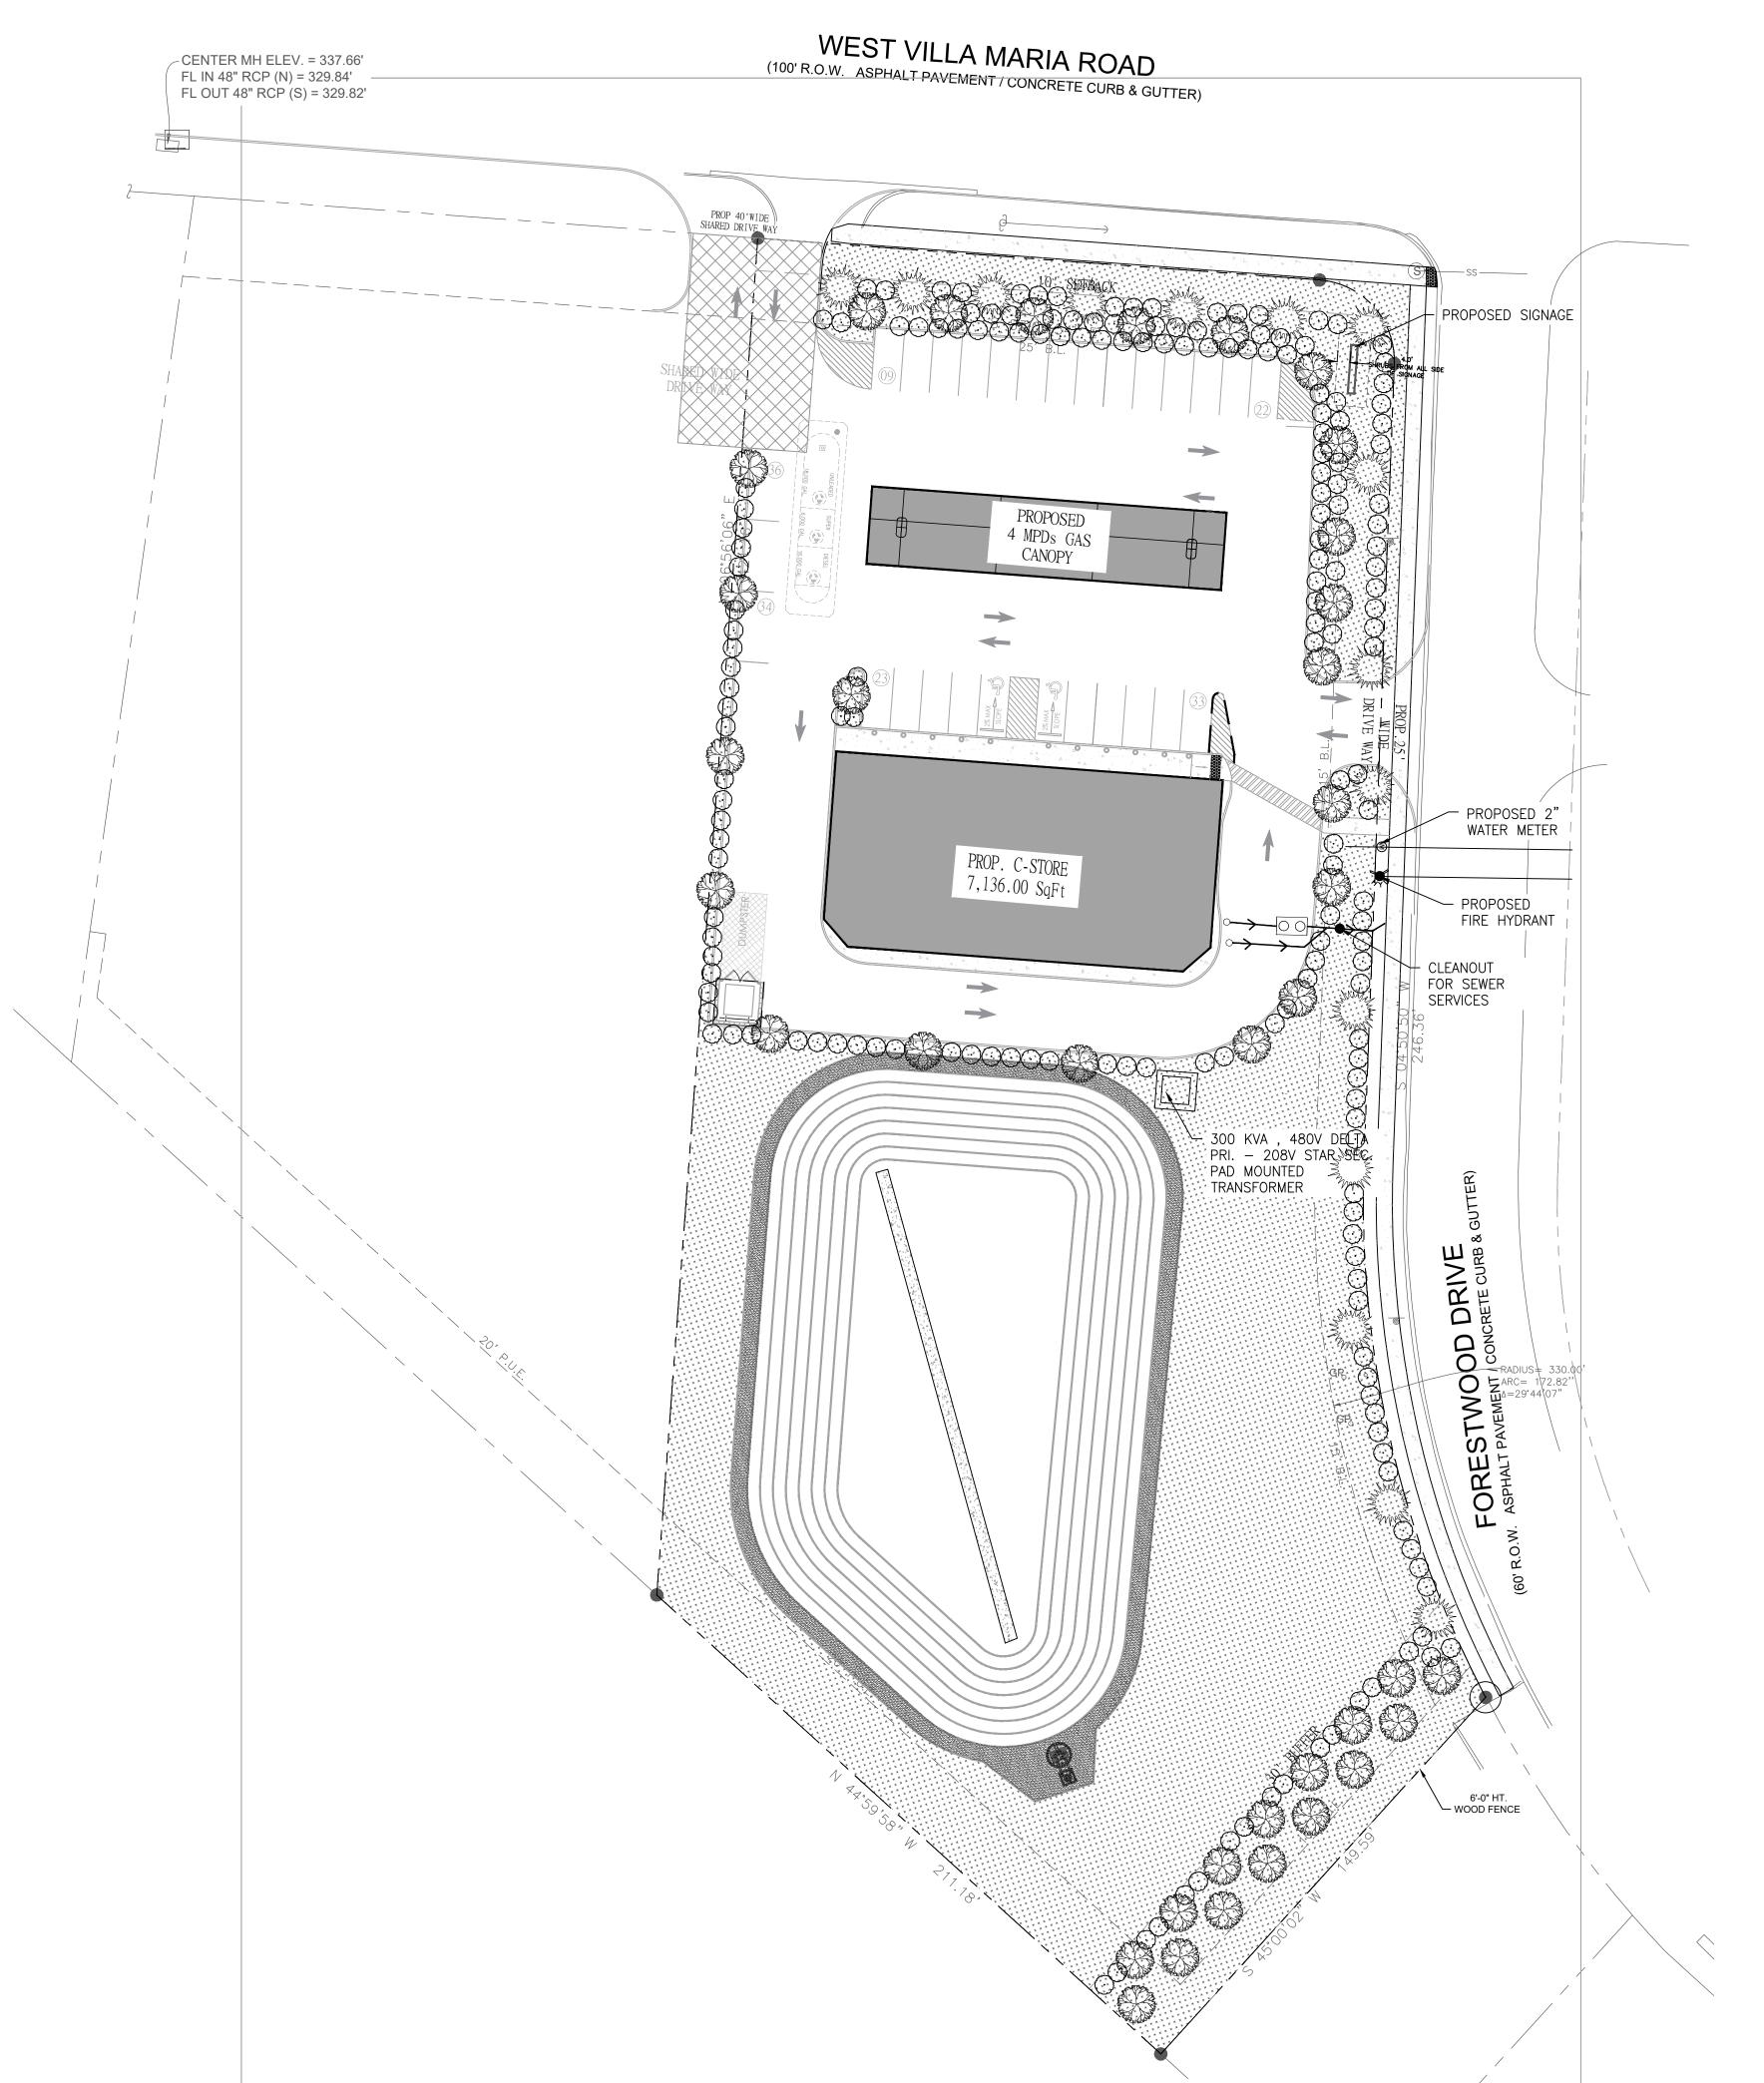
ASHLEY BICE 10/29/2025 DATE:

ROJECT NUMBER 23—000 SCALE 1'' = 30' DRAWN BY R:R CHECKED BY A.Z SHEET TITLE

> SITE **PLAN**

DRAWING NUMBER:

C-1.0



MAKMO DESIGN - DESIGN WITH A DIFFERENT APPROACH -

LANDSCAPING

SYMBOL	SIZE	OFFICIAL NAME	#	SF VALUE	TOTAL
	2" CALIPER	LIVE OAK QUERCUS VIRGINIANA CANOPY TREE	33	200	6,600
all and a second of the second	2" CALIPER	DYNAMITE CREPE MYRTLE LAGERSTROEMIA INDICA DYNAMITE) NON-CANOPY TREE	14	150	2,100
\odot	5 GAL. 2'-0" o.c.	KNOCK-OUT ROSE (ROSE RADRAZZ) SHRUB	140	10	1,400

NOTE:

- 1. LANDSCAPING USED TO SCREEN PARKING LOTS MUST BE DENSE SHRUBBERY HAVING YEAR-ROUND FOLIAGE.
- 2. THE LANDSCAPING SCREENING SHALL FOLLOWS THE PATTERN REQUIRED IN THE ORDINANCE.

LANDSCAPE ANALYSIS:

1 -CONSTRUCTION ACTIVITIES;

2- REQUIREMENTS;

PARKING & PAVEMENT = 33,490 SF BUILDINGS = 7,136 SF

NET TOTAL = 40,626 SF

BUILDING , PARKING , & PAVEMENT 40,626 SF @ 17% = 6,906 SF NET TOTAL = 6,906 SF

NOT LESS THAN 50% OF REQUIRED AREA SHALL BE TREES—3,453 SF REQ'D; 5,700 PROVIDED

NOT LESS THAN 50% OF TREE PLANTED SHALL BE CANOPY; 1,727 SF REQ'D; 3400 PROVIDED

3 - PROVIDED ;

NET TOTAL

CANOPY TRESS
18 @ 200 SF = 3600 SF

NON-CANOPY TRESS
14 @ 150 SF = 2100 SF

SHRUB 140 @ 10 SF = 1,400 SF

TOTAL AREA REQUIRED: 6,906 SF

LANDSCAPED AREA PROVIDED: 7,100 SF

4- BUFFER REDUCTION LANDSCAPING REQUIREMENT FOR THE REDUCED BUFFER AREA, THIS LANDSCAPING SHOULD BE COUNTED SEPARATELY FROM THE GENERAL17% REQUIREMENT.

= 7,100 SF

BUFFER LANDSCAPING CALCULATION:

BUFFER AREA: 20 FT X 150 FT = 3,000 SF CANOPY TREES FOR BUFFER: 1 TREE PER 200 SF

REQUIRED CANOPY TREES: 3,000 SF / 200 SF PER TREE = 15 CANOPY TREES

NOTE:
AUTOMATIC IRRIGATION IS REQUIRED FOR THIS PROJECT
ALL PARKING ISLANDS MUST HAVE A CANOPY TREE.

LANDSCAPING CALCULATIONS:

A. STREET TREES:
Length of property line in lineal feet as measured along all sides of the property fronting on a public street(s).

174.32/30 = 5.81 Street trees require on WEST VILLA MARIA ROAD
246.36/30 = 8.21 Street trees require on FORESTWOOD DRIVE

B. PARKING LOT TREES:

Number of new parking stalls to be constructed 30/10 =3.0 Parking lot trees required.

C. TOTAL TREE REQUIREMENT:

(Staff may create an artificial lot)

A. + B. = <u>17</u> total number of street and parking lot trees required.

D. SHRUBS: (Are required for new or the expanded portion of parking lots)

Total number of Street trees required, from A above 14 x 10 =140 shrubs.

E. LANDSCAPE BUFFER: 6' high screening fence, or 15

ALL NAILS AND HARDWARE TO BE HOT DIPPED GALVANIZED


POSTS TO BE WOLMANIZED PINE GRADE C OR BETTER STRINGERS AND PLANKS TO BE WESTERN RED CEDAR #1

1 WOOD FENCE


SCALE: N.T.S.

6' high screening fence, or 15' wide evergreen planting strip along the total length of property line adjacent to existing single-family residential, or limit of expansion adjacent to existing single-family residential.

(Site plan must show land use on all side of the property)

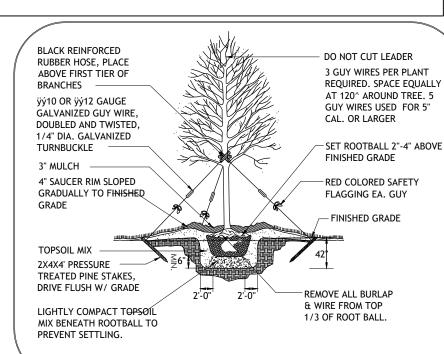


Tree Planting Detail

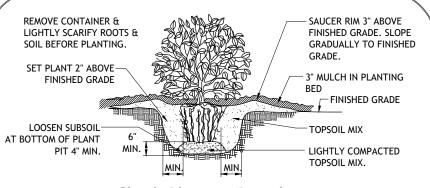

Shrub Planting Detail



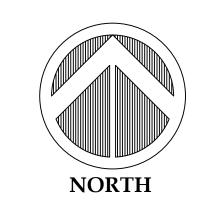

30 15 0 30 60 SCALE ISSUE FOR:

FOR INTER REVIEW ONLY

BID ONLY

PERMITS SET

CONSTRUCTION SET

REVISIONS:

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OPOSED C STORE & GAS STATIO LOCATED AT 001 W VILLA MARIA RD, BRYAN, TX 77801

ASHLEY BICE

134060

CENSED

ONA VENDER

125

DATE: 7/3/2025

PROJECT NUMBER	:	23-000
SCALE	:	1" = 30'
DRAWN BY	:	R.R
CHECKED BY	:	A.Z
SHEET TITLE	:	

LANDSCAPE PLAN

DRAWING NUMBER:

L-100